


GENERAL NOTES:

1. THE GENERAL CONTRACTOR IS RESPONSIBLE TO VISIT THE SITE AND BECOME FAMILIAR WITH THE SITE CONDITIONS PRIOR TO THE START OF CONSTRUCTION.
2. THE GENERAL CONTRACTOR IS RESPONSIBLE TO VERIFY ALL DIMENSIONS, ELEVATIONS AND CONDITIONS PRIOR TO BEGINNING ANY WORK. NOTIFY THE ARCHITECT OF ANY DISCREPANCIES. DO NOT SCALE DRAWINGS.
3. REFER TO THE SOILS REPORT FOR SUBSURFACE CONDITIONS, BEARING CAPACITIES, ETC. NOTIFY THE ARCHITECT, ENGINEER AND OWNER OF ANY DISCREPANCY BETWEEN THIS REPORT AND THE PLANS, SPECIFICATIONS OR SITE CONDITIONS.
4. ALL WORK AND MATERIALS SHALL CONFORM TO THE LATEST BUILDING CODES, ORDINANCES AND REGULATIONS OF THE CITY OR COUNTY WITH JURISDICTION.
5. THE GENERAL CONTRACTOR SHALL BE RESPONSIBLE FOR OBTAINING AND PAYING FOR ALL PERMITS, LICENSES, INSPECTIONS AND TESTING AS REQUIRED BY THE CONTRACT DOCUMENTS OR ANY GOVERNMENT AGENCY.
6. THE GENERAL CONTRACTOR IS RESPONSIBLE TO PROVIDE ALL LABOR, MATERIALS, EQUIPMENT, TOOLS, TRANSPORTATION, UTILITIES, OTHER SERVICES AND RELATED TASKS NECESSARY FOR PROPER EXECUTION OF THE CONSTRUCTION REQUIRED BY THE CONTRACT DOCUMENTS.
7. THE GENERAL CONTRACTOR IS TO ASSUME SOLE AND COMPLETE RESPONSIBILITY FOR JOBSITE CONDITIONS. COMPLY WITH SAFETY REGULATIONS AND RESTRICTIONS AS REQUIRED FOR WORKER AND PEDESTRIAN PROTECTION DURING THE COURSE OF CONSTRUCTION OF THIS PROJECT. PROVIDE PROTECTION AS REQUIRED TO PREVENT ANY DAMAGE TO EXISTING CONSTRUCTION WITHIN AND ADJACENT TO THE JOBSITE. WHERE DAMAGE OCCURS, REPAIR OR REPLACE DAMAGED AREA AND/OR MATERIAL AS REQUIRED TO THE OWNER'S APPROVAL AT NO ADDITIONAL COST. THESE REQUIREMENTS SHALL APPLY CONTINUOUSLY AND NOT BE LIMITED TO NORMAL HOURS.
8. UNLESS OTHERWISE SHOWN OR NOTED, THE GENERAL CONTRACTOR SHALL BE RESPONSIBLE FOR COORDINATING THE LOCATION AND THE PLACEMENT OF ANY INSERTS, HANGARS, PIPE SLEEVES, HOLES OR ANCHOR BOLTS THAT ARE REQUIRED BY THE MECHANICAL OR ELECTRICAL EQUIPMENT.
9. THE GENERAL CONTRACTOR SHALL BRING ANY REVISION OR ADDITIONAL WORK REQUIRED BY FIELD CONDITIONS OR LOCAL GOVERNING AUTHORITIES TO THE ATTENTION OF THE ARCHITECT AND OWNER BEFORE PROCEEDING.
10. THE GENERAL CONTRACTOR IS RESPONSIBLE TO VERIFY THE SIZE AND LOCATION OF ALL UTILITY LINES AND STUBS TO THE BUILDING(S). BRING ALL UTILITY LINES (WATER, SEWER, GAS, STORM DRAIN, TELEPHONE AND ELECTRICAL, ETC.) INTO THE BUILDING AS INDICATED ON THE CONSTRUCTION DOCUMENTS. BRING ANY DISCREPANCIES TO THE ATTENTION OF THE ARCHITECT, OWNER & CIVIL ENGINEER.
11. UNLESS NOTED OTHERWISE, ALL DETAILS, SECTIONS, AND NOTES ON THE DRAWINGS ARE INTENDED TO BE TYPICAL FOR SIMILAR SITUATIONS ELSEWHERE.
12. NO BUILDING OR PORTION OF A BUILDING SHALL BE OCCUPIED OR USED FOR STORAGE PRIOR TO THE ISSUANCE OF THE TEMPORARY CERTIFICATE OF OCCUPANCY. APPROVAL FOR OCCUPANCY IS ONLY GRANTED AFTER ACCEPTANCE BY GOVERNING AGENCIES.
13. THE REMOVAL OF ALL HAZARDOUS CONTAINING MATERIALS IS THE SOLE RESPONSIBILITY OF THE OWNER. SHOULD ANY MATERIALS BE ENCOUNTERED DURING ANY PHASE OF CONSTRUCTION, OR SUSPECTED TO BE HAZARDOUS, THE CONTRACTOR SHALL STOP WORK IMMEDIATELY AND NOTIFY OWNER.

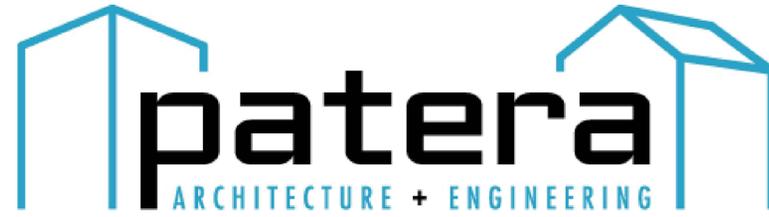

Sri Lakshmi Narasimha Temple

3705 S. Swartz Rd.
New Berlin WI



PROJECT INFORMATION:

GOVERNING CODE:	WISCONSIN ADOPTED 2015 IBC	
CONSTRUCTION TYPE:	2B	
OCCUPANCY CLASSIFICATION:	A-3	
OCCUPANCY SEPARATION:	NON SEPARATED USE	
REQUIRED SEPARATION:	NONE	
MAXIMUM HEIGHT:	75'	
BUILDING HEIGHT:	28'	
NUMBER OF STORIES ALLOWED:	3	
NUMBER OF STORIES:	1	
SPRINKLER SYSTEM:	SPRINKLERED PER NFPA 13	
ALLOWABLE AREA PER FLOOR :	38,000sf	
ALLOWABLE AREA INCREASE - FRONTAGE:	28,500sf	
TOTAL ALLOWABLE BUILDING AREA:	66,500sf / floor	
TOTAL BUILDING AREA	10,087sf	
FIRST FLOOR AREA- EXISTING	2,773sf	
FIRST FLOOR AREA - NEW	4,606sf	
SECOND FLOOR AREA - EXISTING	2,708sf	
FIRE EXTINGUISHERS:	PER IFC	
PLUMBING FIXTURE REQUIREMENTS: (per TABLE 2902.1)		
WATER CLOSETS "TOTAL REQUIRED"		
MALE	= xx REQUIRED	2 PROPOSED
FEMALE	= xx REQUIRED	2 PROPOSED
LAVATORIES	= xx REQUIRED	4 PROPOSED
WATER CLOSETS "A-2"		
WATER CLOSETS "A-3"		

SHEET INDEX:

C000	TITLE SHEET
C200	SITE PLAN
C201	FUTURE DEVELOPMENT
C300	GRADING PLAN
1 of 1	PHOTOMETRIC PLAN
	LANDSCAPING PLAN
A0.1	ARCHITECTURAL SITE PLAN
A1.1	EXISTING / DEMO FLOOR PLANS
A1.2	PROPOSED FLOOR PLAN
A2.1	EXISTING / DEMO ELEVATIONS
A2.2	EXISTING / DEMO ELEVATIONS
A2.3	ELEVATIONS
A2.4	ELEVATIONS

PROJECT TEAM:

OWNER:

Sri Lakshmi Narasimha Temple
3705 S. Schwartz Rd.
New Berlin, WI 53146
TEL: (414) 555-5555
email www.xxx.com
ATTN: Krish Narayanan

ARCHITECT:

PATERA, LLC
4040 N. Calhoun Rd.
Brookfield, WI 53005
TEL: (262) 786-6776
email steve@paterallc.com
ATTN: Seven M. Esser

GENERAL CONTRACTOR/DEVELOPER:

Xxx, Inc.
XXX Ave.,
New Berlin, WI 53151
TEL: (414) 555-5555
email www.xxx.com
ATTN: Mr. Smith



VICINITY MAP
SCALE 1"=750'



SITE IMPROVEMENT PLANS FOR 3705 SWARTZ ROAD NEW BERLIN, WI

SHEET INDEX	
C000	TITLE SHEET & VICINITY MAP
C200	SITE PLAN
C201	FUTURE DEVELOPMENT
C300	GRADING PLAN

SITE IMPROVEMENT PLANS FOR
 3705 SWARTZ ROAD
 NEW BERLIN, WI

LYNCH & ASSOCIATES
 ENGINEERING CONSULTANTS, LLC

BENCHMARKS

FOUND CONC. MON.	942.37	N: 150,046.81	E: 697,759.02
FOUND CONC. MON.	957.42	N: 150,060.89	E: 700,423.71
FOUND IRON PIPE	987.03	N: 148,730.32	E: 698,674.77
FOUND IRON PIPE	970.23	N: 148,175.65	E: 698,664.85

CONTACT INFORMATION

COMPANY NAME	ADDRESS	CONTACT	PHONE	EMAIL
LYNCH & ASSOCIATES	S. WESTRIDGE DR. NEW BERLIN, WI 53151	TIM LYNCH, P.E.	262.402.5040	tlynch@lynch-engineering.com

REVISIONS

NO.	REVISION	DATE
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ISSUED FOR
CONSTRUCTION

PLAN DATE 02.08.2022

PROJECT NO.
22-0003


SHEET NO.

C000


Symbol	Label	Quantity	Manufacturer	Catalog Number	Description	Number Lamps	Lumens Per Lamp	Light Loss Factor	Wattage	Plot
OA	OA	5	SIGNIFY GARCO	ECF-S-48L-1.2A-NW-Q2-4	Ecoform Area LED ECF - Small, 48 LED's, 4000K CCT, TYPE 4 OPTIC, No Shield	1	23178	1	182.71	
WA	WA	13	Performance N Lighting	070213	QIASAR 30 DOUBLE TECH 35W 840 Type I 0-10V Iron gray	1	2251	1	35	

Statistics


Description	Symbol	Avg	Max	Min	Max/Min	Avg/Min
ENTIRE SITE PLAN	+	1.2 fc	13.2 fc	0.0 fc	N/A	N/A
SITE PLAN- NORTH AREA	✕	3.0 fc	13.2 fc	0.3 fc	44.0:1	10.0:1
SITE PLAN- SOUTH AREA	✕	2.2 fc	7.7 fc	0.2 fc	38.5:1	11.0:1
SITE PLAN- EAST AREA	✕	1.1 fc	12.0 fc	0.0 fc	N/A	N/A
SITE PLAN- EXISTING AREA	✕	0.3 fc	1.9 fc	0.0 fc	N/A	N/A

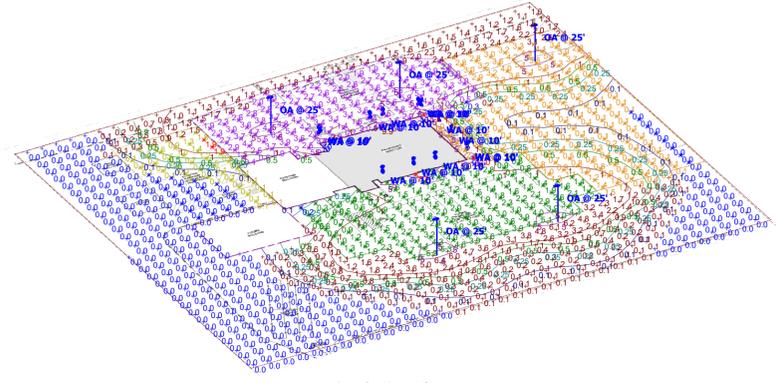

TYPE "OA"


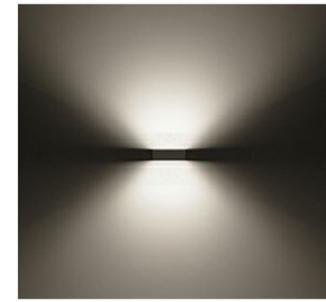


TYPE "WA"

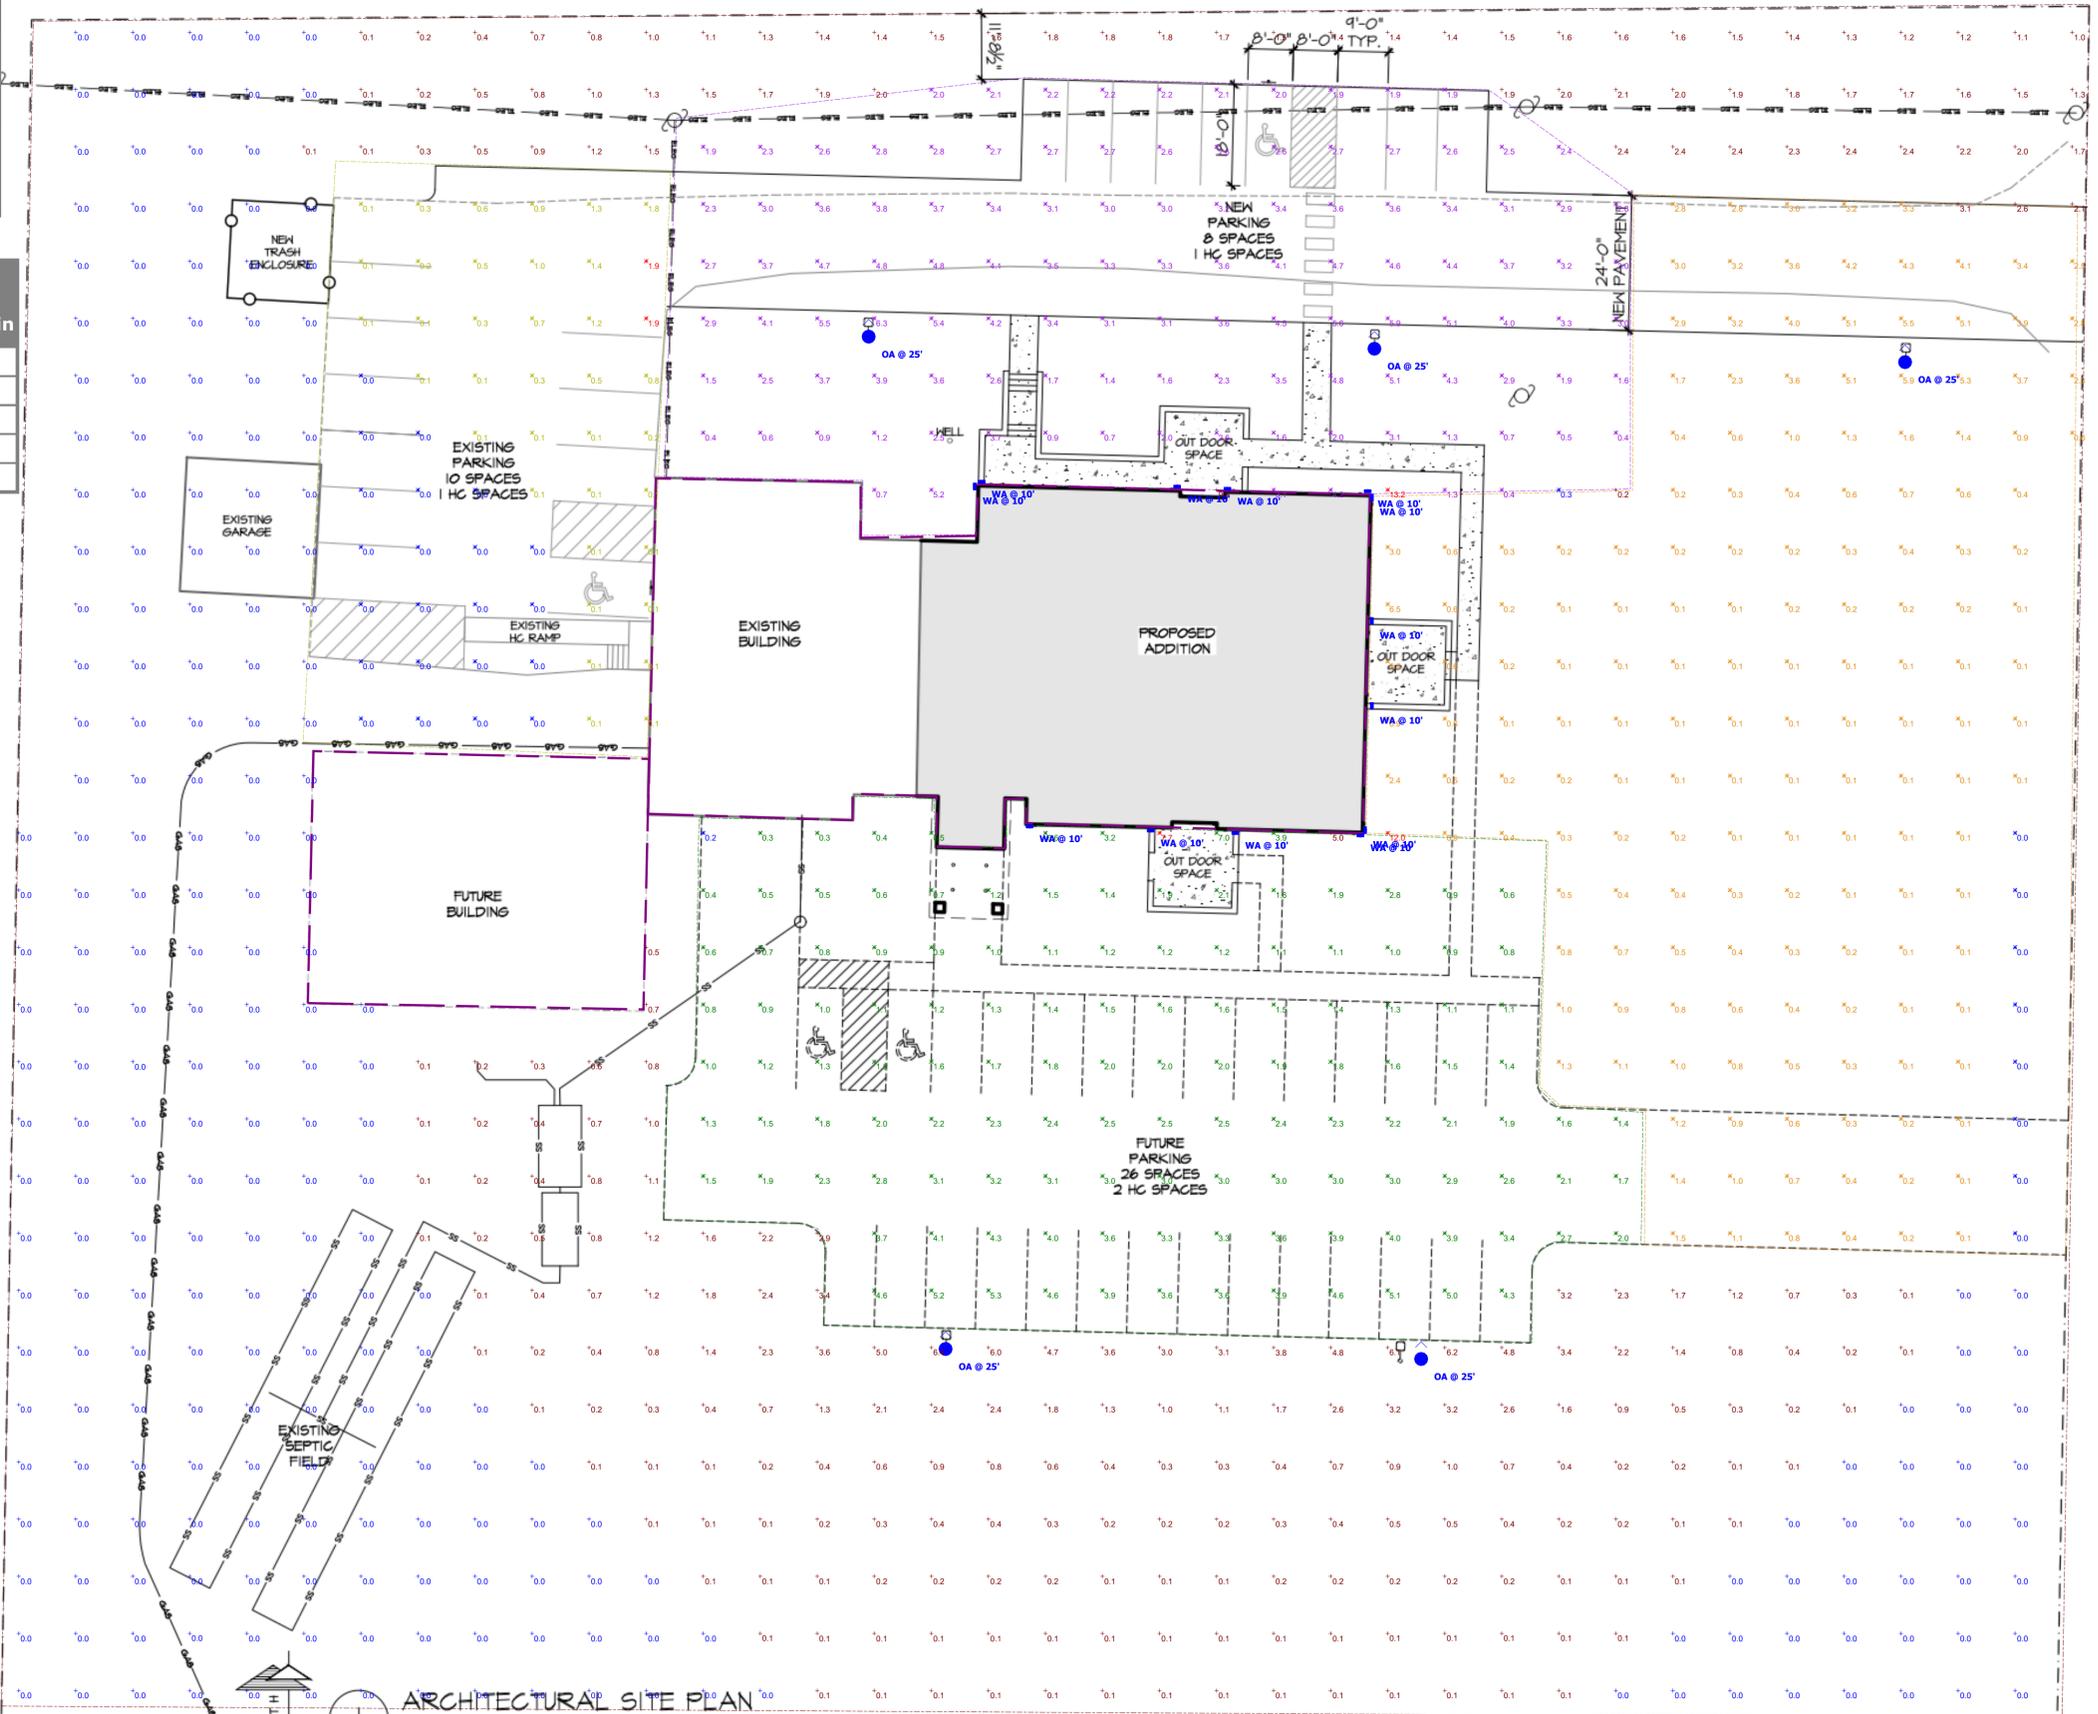

Note

- CONTACT SPECTRUM LIGHTING FOR ANY QUESTIONS - (262) 970-0300.
- MOUNTING HEIGHTS SHOWN ON PLANS.

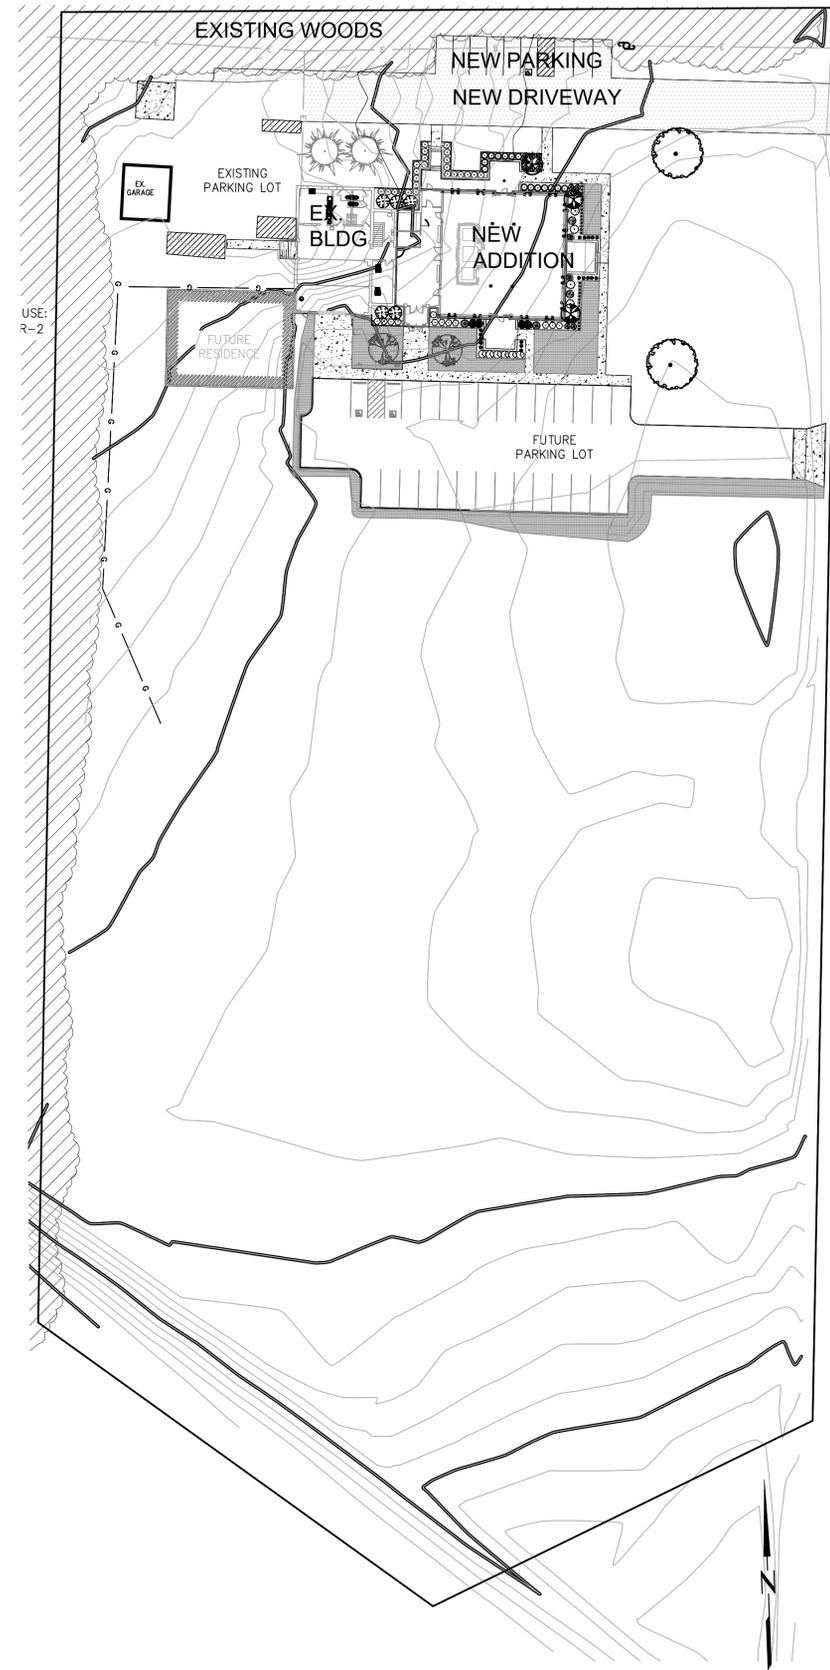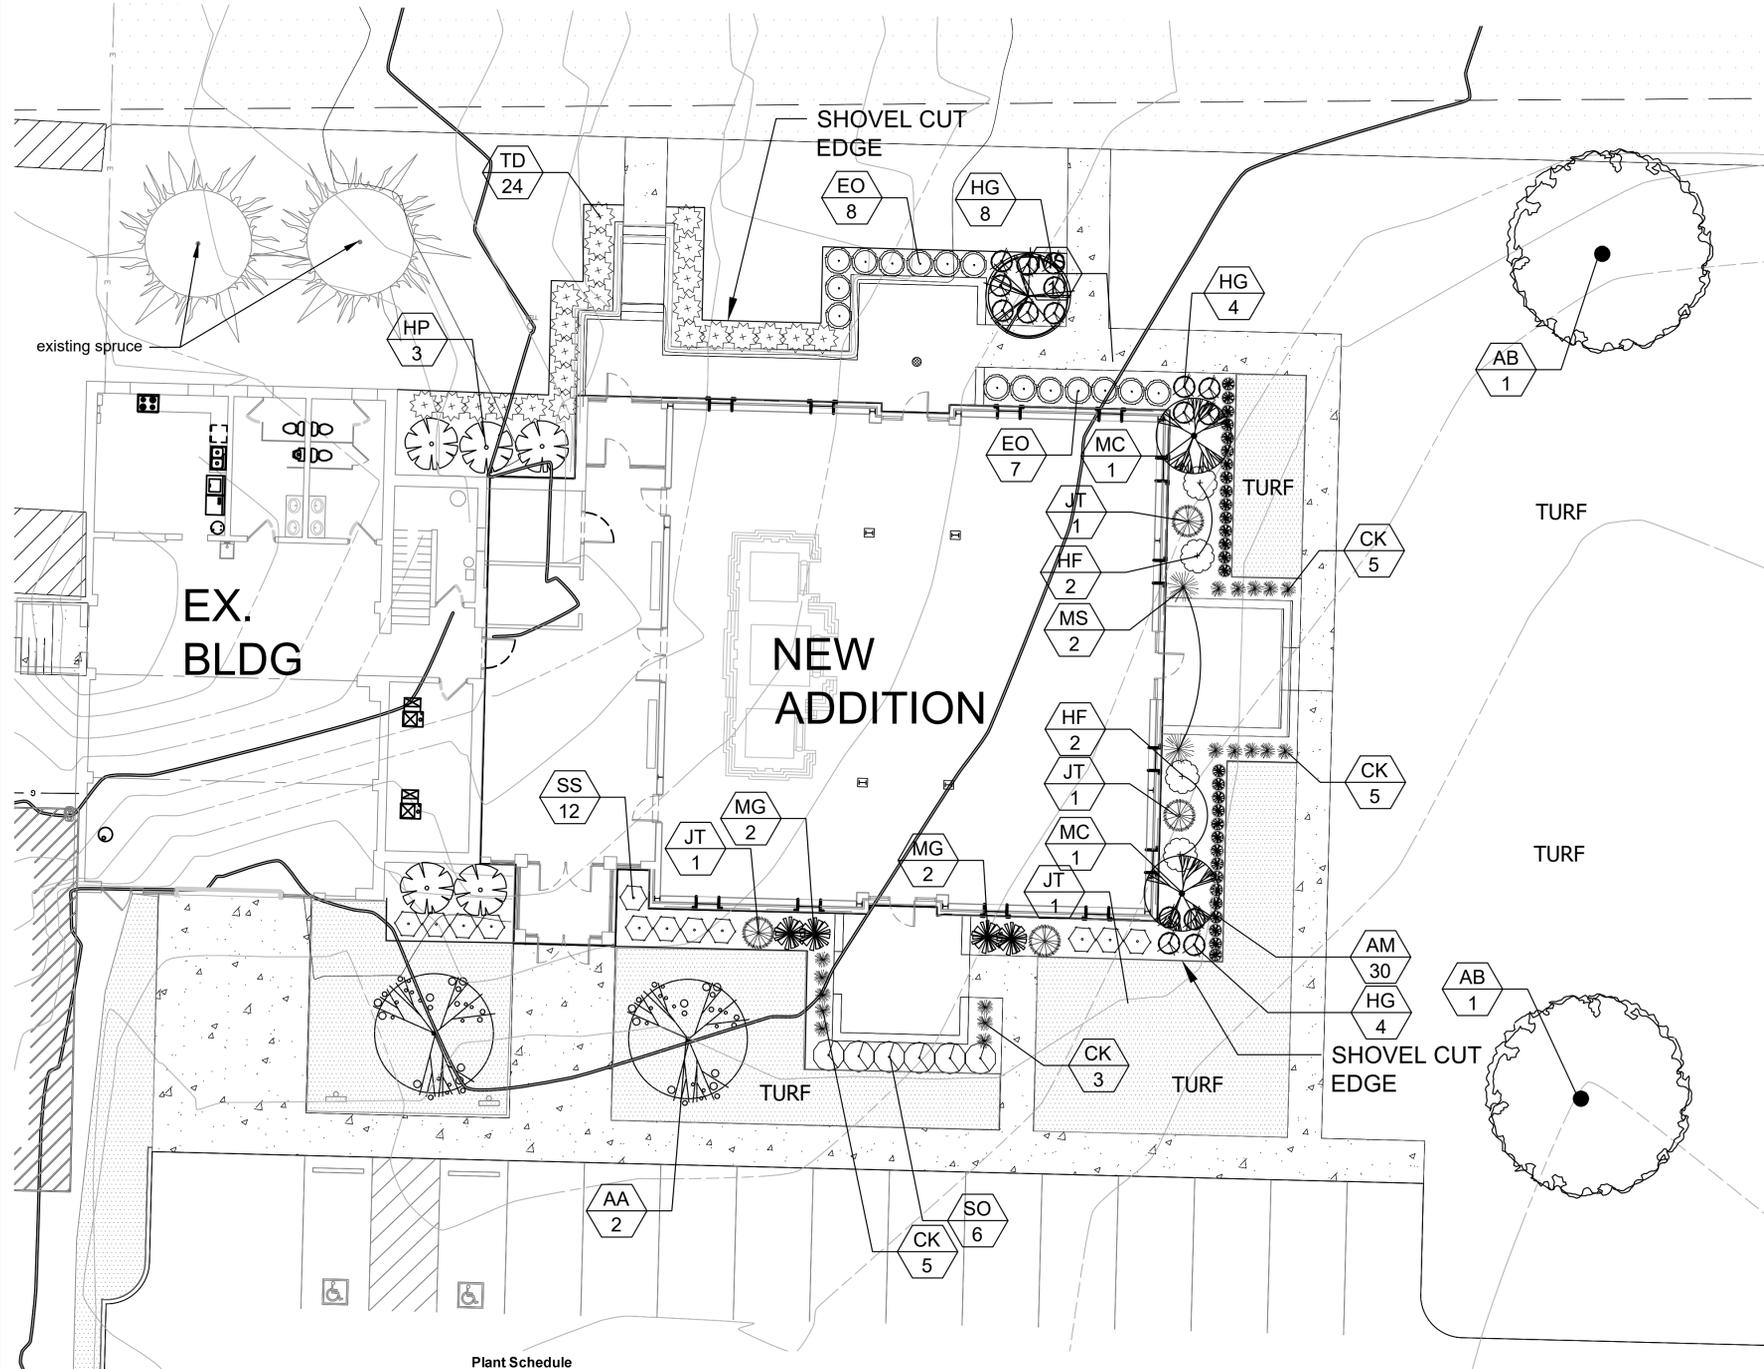

Plant Schedule

Key	Botanical Name	Common Name	Qty.	Size	Root	Spacing
SHADE TREES						
AB	Acer x freemanii 'Jeffersred'	Autumn Blaze Maple	2	2.5-3" Cal.	B&B	as shown
AA	Acer x freemanii 'Armstrong'	Armstrong Maple	2	2-2.5" Cal.	B&B	as shown
ORNAMENTAL TREES						
MC	Malus x 'Coralcole'	Coralburst Crabapple	2	1.5-2" cal.	B&B	as shown
MS	Malus sargentii	Sargent Crab	1	1.5-2" cal.	B&B	as shown
DECIDUOUS SHRUBS						
EO	Euonymus alatus Odom 'Little Moses'	Little Moses Dwarf Burning Bush	15	18" High	B&B	as shown
HF	Hydrangea paniculata 'Fire and Ice'	Fire and Ice Hydrangea	4	24" High	Container	48" o.c.
HP	Hydrangea paniculata 'Pinky Winky'	Pinky Winky Hydrangea	5	24" High	Container	8" o.c.
SS	Sorbaria sorbifolia 'Sem'	Sem Ashleaf Spirea	12	18" High	Container	48" o.c.
SO	Spiraea x fritschiana 'Spot On'	Spot On Spirea	6	18" High	Container	48" o.c.
EVERGREEN SHRUBS						
JT	Juniperus virginiana 'Taylor'	Taylor Juniper	3	5' High	B&B	as shown
TD	Taxus x media 'Densiformis'	Dense Spreading Yew	24	24" spread	B&B	48" o.c.
PERENNIALS/GRASSES						
AM	Allium x Millenium	Millenium Globe Lily	30	1 Gal.	Container	12" o.c.
CK	Calamagrostis acutiflora 'Karl Foerster'	Feather Reed Grass	18	1 Gal.	Container	20" o.c.
HG	Hosta x 'Guacamole'	Guacamole Hosta	16	1 Gal.	Container	48" o.c.
MG	Miscanthus sinensis 'Gracillimus'	Gracillimus Maiden Grass	2	1 Gal.	Container	48" o.c.
MM	Miscanthus sinensis 'Morning Light'	Morning Light Maiden Grass	2	1 Gal.	Container	48" o.c.



Gerard A. Rewolinski



LANDSCAPE PLAN



SITE PLAN



PLANTINGS, STRUCTURES AND OTHER REPRESENTATIONS SHOWN ON THIS PLAN ARE FOR THE PURPOSE OF CONVEYING LANDSCAPE DESIGN FEATURES. REFER TO PREPARED CONTRACT DOCUMENTS FOR SPECIFIC ITEMS INCLUDED IN ANY PARTICULAR PHASE OF LANDSCAPE CONSTRUCTION.



Premier Landscapes

LANDSCAPE DEVELOPMENT FOR
SRI LAKSHMI TEMPLE-ADDITION
3705 S. SWARTZ ROAD
NEW BERLIN, WISCONSIN

LANDSCAPE ARCHITECTURE
DESIGN BY: GAR
DRAWN BY: GAR
DATE: 6/10/2022
REVISED:
SCALE: VARIES
SHEET: L100


TREES ON THE MOVE
5611 S. Calhoun Road
New Berlin, WI 53151
Phone: (262) 679-5200
treesonthemove.com

SITE PLAN GENERAL NOTES:

1. ALL PAVING RADII SHALL BE 4'-0" UNLESS NOTED OTHERWISE.
2. PROVIDE CONCRETE SIDEWALKS AS INDICATED ON PLAN.
3. UTILITY DESIGN AND WORK BY DESIGN / BUILD CONTRACTOR.
4. GRADINGS AT ACCESSIBLE ROUTE TO COMPLY WITH THE WISCONSIN ADOPTED 2015 IBC CHAPTER 11 AND THE 2004 ANSI ITI DESIGN GUIDELINES.
5. FINISHED FLOOR ELEVATION = 100'-0" ON ARCHITECTURAL DRAWINGS VERIFY ACTUAL ELEVATION WITH CONTRACTOR.
6. SITE ENGINEERING (GRADING, STORM WATER DRAINAGE, ETC.) BY OTHERS.
7. ALL PROPERTY LINE BEARINGS AND LENGTHS BASED ON OWNER AND CONTRACTOR PROVIDED DATA.
8. CONSTRUCTION SITE EROSION AND SEDIMENTATION CONTROL SHALL COMPLY WITH THE REQUIREMENTS OF THE TOWN/VILLAGE/CITY AND SHALL EMPLOY EROSION CONTROL METHODS AS SHOWN AND SPECIFIED IN THE DEPARTMENT OF NATURAL RESOURCES WISCONSIN CONSTRUCTION SITE BEST MANAGEMENT PRACTICES HANDBOOK (BMP HANDBOOK).
9. ALL EROSION CONTROL MEASURES SHALL BE ADJUSTED TO MEET FIELD CONDITIONS AT THE TIME OF CONSTRUCTION AND SHALL BE INSTALLED PRIOR TO ANY GRADING OR DISTURBANCE OF EXISTING SURFACE MATERIAL ON THE SITE.
10. PERIODIC INSPECTION AND MAINTENANCE OF ALL EROSION CONTROL STRUCTURES SHALL BE PROVIDED TO INSURE INTENDED PURPOSE IS ACCOMPLISHED. CONTRACTOR SHALL BE RESPONSIBLE FOR CLEANUP AND REMOVAL OF ALL SEDIMENT LEAVING PROPERTY. EROSION CONTROL MEASURES SHALL BE IN WORKING CONDITION AT END OF EACH WORK DAY. EROSION CONTROL MEASURES SHALL BE MAINTAINED ON A CONTINUING BASIS UNTIL SITE IS FULLY STABILIZED.
11. SILT FENCE SHALL BE INSTALLED IN ALL LOCATIONS WHERE POTENTIAL RUNOFF AND CONTAMINATION MAY OCCUR.
12. ALL EROSION AND SEDIMENT CONTROL PRACTICES TO BE CHECKED FOR STABILITY AND OPERATION FOLLOWING EVERY RUNOFF-PRODUCTION RAINFALL EVENT. ANY NEEDED REPAIRS SHALL BE MADE IMMEDIATELY TO MAINTAIN ALL PROTECTION AS DESIGNED.
13. SEDIMENT IS TO BE REMOVED FROM BEHIND THE SEDIMENT FENCE WHEN IT BECOMES 25 FEET DEEP AT THE FENCE. REPAIR THE FENCE AS NECESSARY TO MAINTAIN BARRIER.
14. SEE ALL RELATED DETAILS AND REMAINING SHEETS SPECIFICATION FOR ADDITIONAL INFORMATION AND HOW IT RELATES TO THE SCOPE OF THE PROJECT.
15. ADDITIONAL GRADING OF GRASSED OR LANDSCAPED AREAS MAY BE REQUIRED DUE TO THE PLUMBING, SANITARY OR OTHER UNDERGROUND UTILITY WORK - REVIEW DOCUMENTS IN THEIR ENTIRETY TO DETERMINE FULL SCOPE OF WORK.

CODED NOTES:

- ① PROVIDE RESERVED PARKING SIGN IN ACCORDANCE WITH TRANS. 200.07 OF THE WISCONSIN ADMINISTRATIVE CODE. 12"x18" MIN. SIZE REQUIRED AT EACH H.C. ACCESSIBLE PARKING STALL (REFER TO 1/AO.1)
- ② PROVIDE RESERVED VAN ACCESSIBLE PARKING SIGN IN ACCORDANCE WITH TRANS. 200.07 OF THE WISCONSIN ADMINISTRATIVE CODE. 12"x18" MIN. SIZE REQUIRED AT EACH H.C. ACCESSIBLE PARKING STALL (REFER TO 2/AO.1)
- ③ ACCESSIBLE PARKING AND ACCESSIBLE PAVED AREA. AREA SHALL HAVE A SLOPE NO GREATER THAN 1:50 (2%) IN ANY DIRECTION AND SHALL BE SLOPED TO DRAIN AWAY FROM CURBS AND/OR SIDEWALKS.
- ④ PAINTED INTERNATIONAL SYMBOL OF ACCESSIBILITY IN ACCORDANCE WITH ADAAG 4.30.7(1). (REFER TO DETAIL X/AO.X)
- ⑤ PROVIDE 4" WIDE PAINTED STRIPING AS INDICATED ON PLAN. PAINT SHALL BE "TRAFFIC YELLOW" PL-4666.
- ⑥ SIDEWALK TO BE FLUSH WITH PARKING LOT PAVING AT (STRIPED) ACCESSIBLE WALK PATH (REFER TO DETAIL X/AO.X & X/AO.X)
- ⑦ ACCESSIBLE PATH OF TRAVEL. REFER TO DETAIL X/AO.X
- ⑧ ASPHALT CONCRETE PAVING. AUTO TRAFFIC (REFER TO X/AO.X)
- ⑨ EDGE OF ASPHALT PAVING - NO CURB.
- ⑩ 8'-0" HIGH VERTICAL WOOD BATTEN FACE ON PRESSURE TREATED WOOD FRAME TRASH ENCLOSURE W/2 - PAIR 6'-4" x 8'-0" WOOD BATTEN FACED ON ON PRESSURE TREATED WOOD FRAMED DOORS. REFER TO SHEET AO.X.
- ⑪ 6" PIPE BOLLARD, SEE DTL. X/AO.X. (X TOTAL)
- ⑫ XX' MASONRY SCREEN / RETAINING WALL. REFER DETAIL X/AO.X FOR INFORMATION, REFER TO STRUCTURAL'S FOR SIZE, REINFORCEMENT AND DETAIL.
- ⑬ SITE LIGHTING, REFER TO ELEC. SHEETS
- ⑭ 4" THICK REINFORCED CONCRETE SLAB ON GRADE W/ 6x6 #2 @ 24" ON CENTER HWF ON 6" LAYER OF FREELY DRAINING COMPACTED GRANULAR BASE COURSE - SLOPE SLAB 1% TO TRENCH GRATE. REFER TO DETAIL X/AO.X FOR EDGE CONDITION.

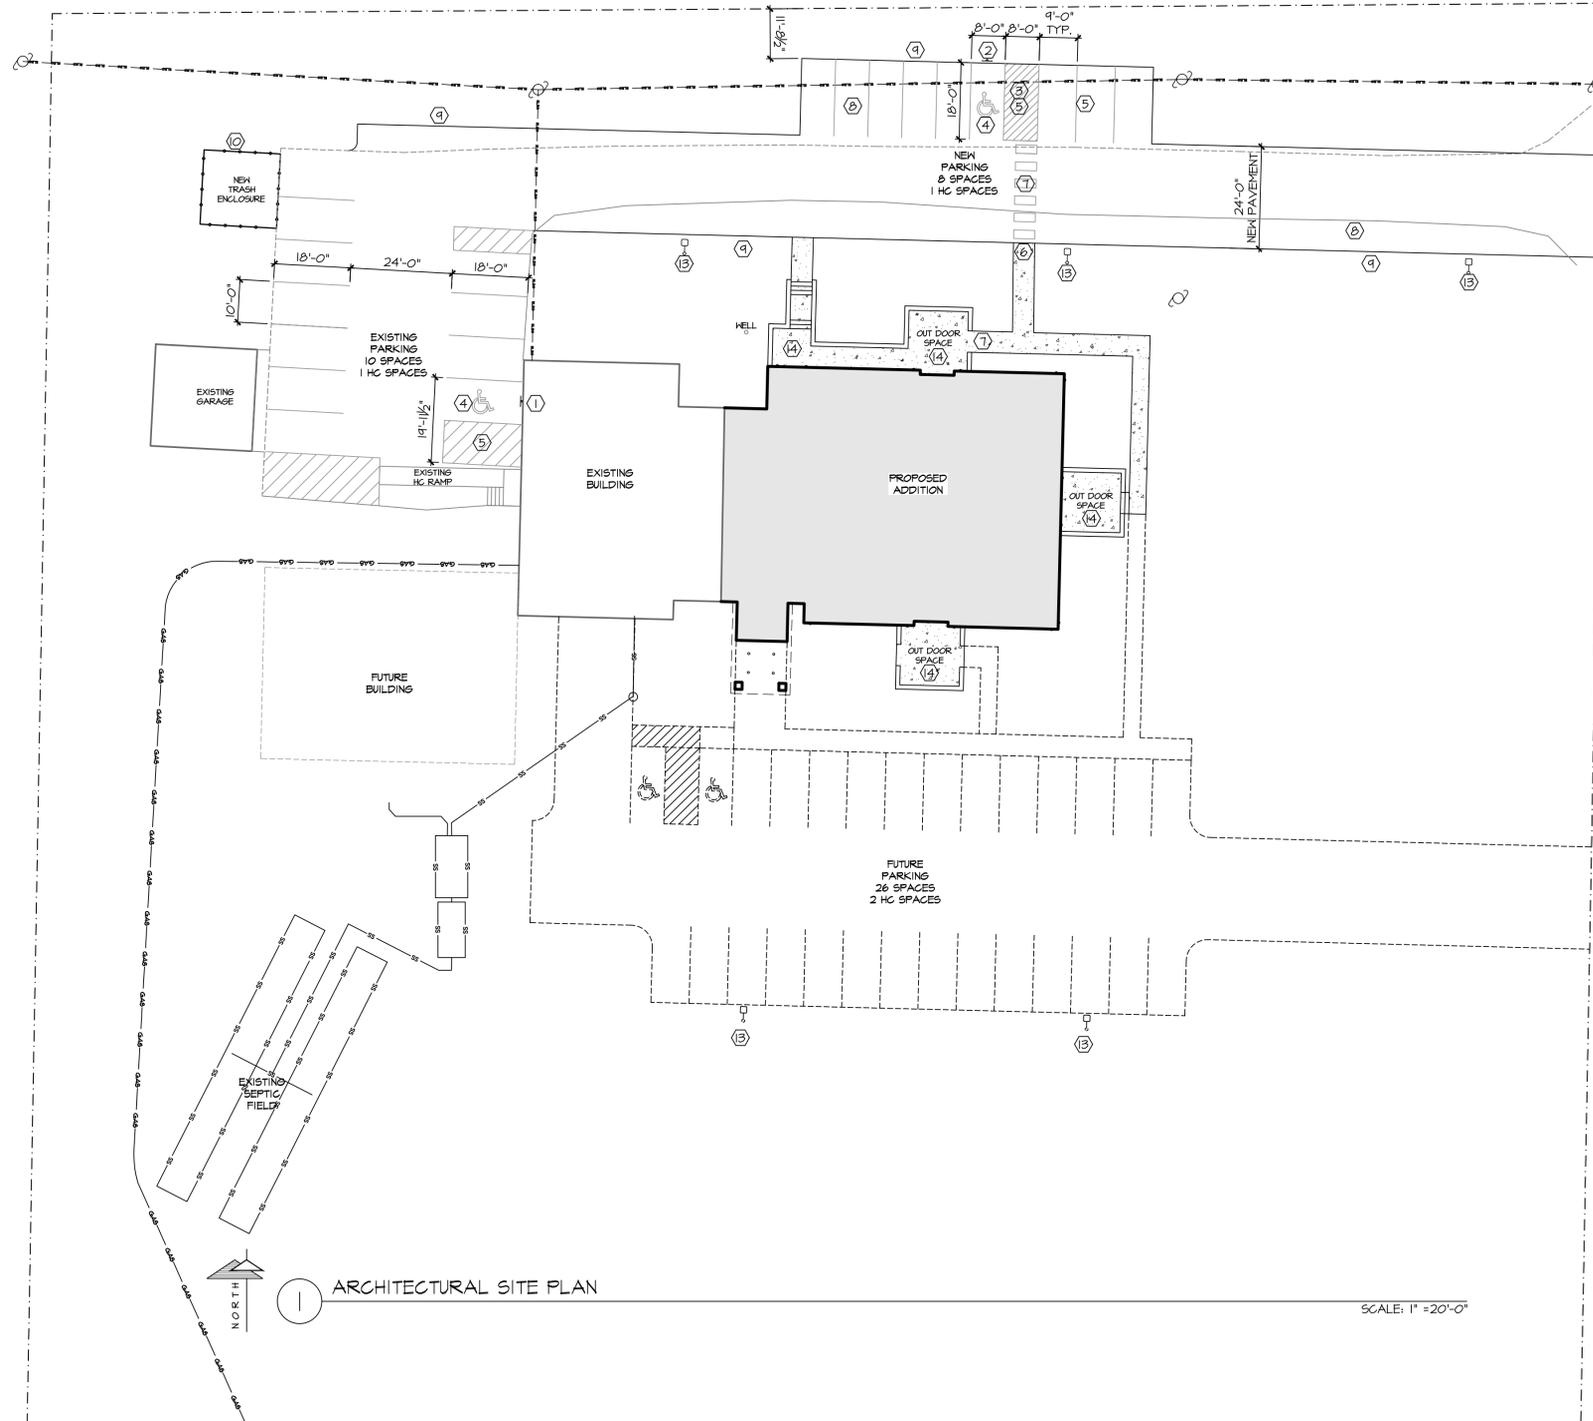

ARCHITECTURAL SITE PLAN

SCALE: 1" = 20'-0"

REVISIONS:

-	X

Sri Lakshmi Narasimha Temple

3705 S. Swartz Rd.
New Berlin, WI
SHEET TITLE:
ARCHITECTURAL SITE PLAN


A0.1

DATE: 06/10/2022
PROJECT NUMBER: 21-530




2 EXISTING / DEMO FIRST FLOOR PLAN

SCALE: 3/16" = 1'-0"

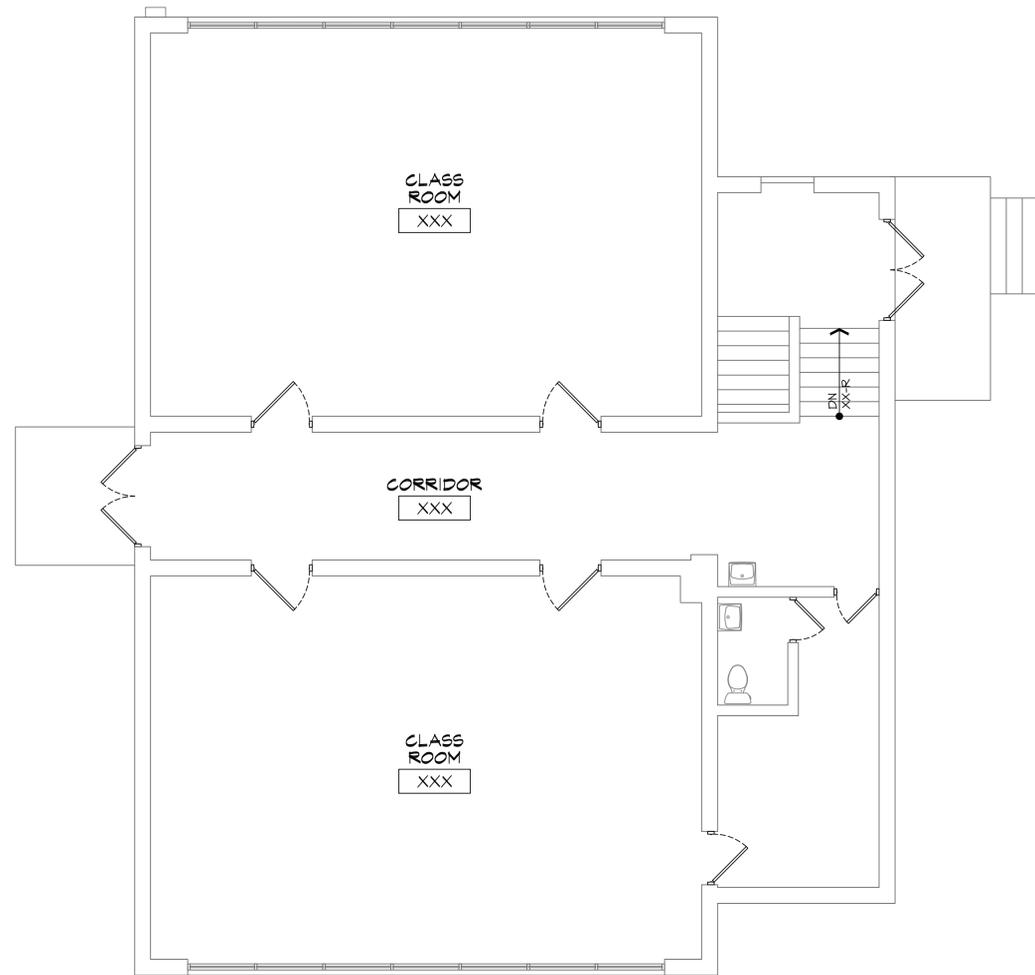

1 EXISTING / DEMO GROUND LEVEL PLAN

SCALE: 3/16" = 1'-0"

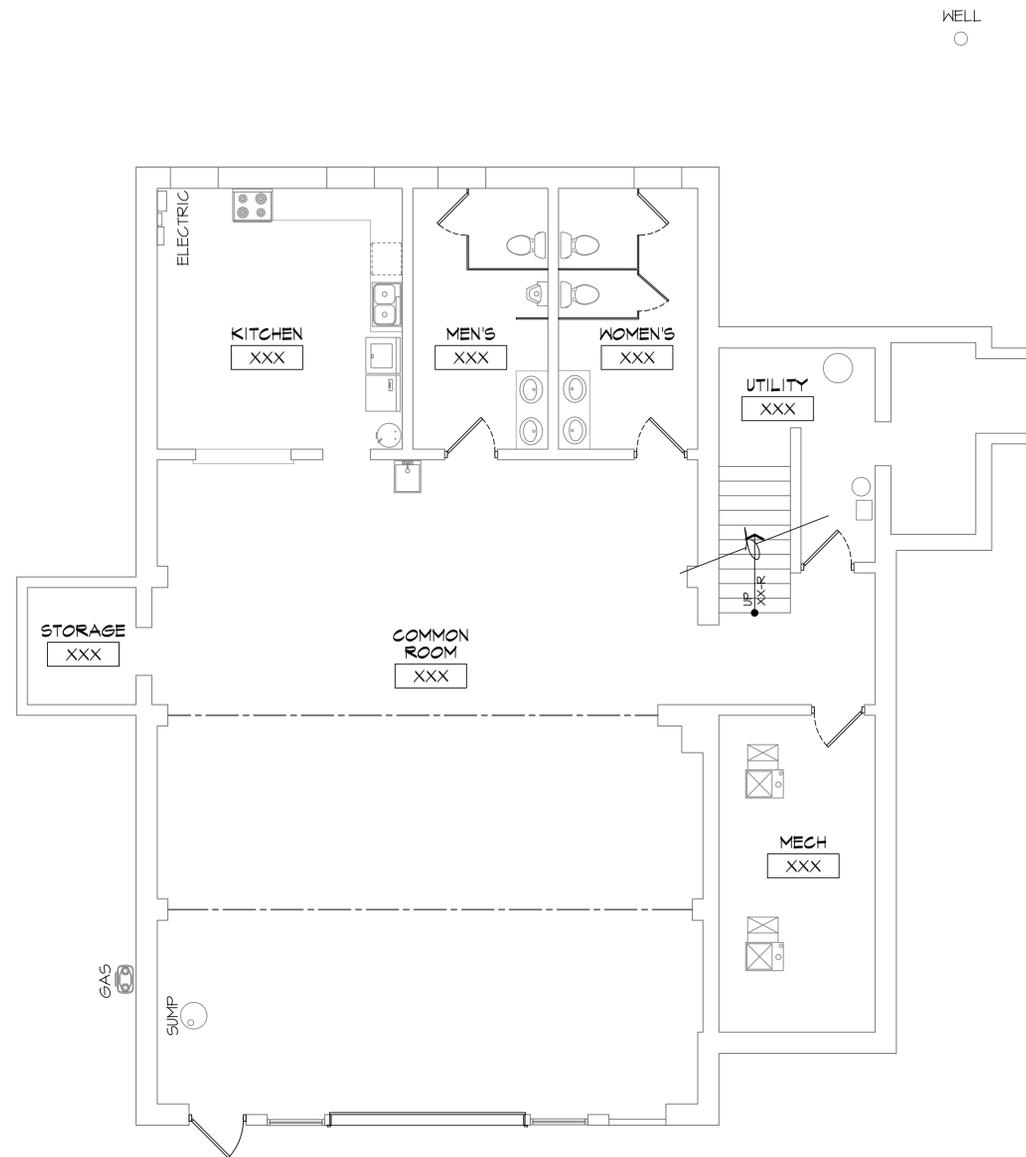

Sri Lakshmi Narasimha Temple

3705 S. Swartz Rd.
New Berlin, WI

SHEET TITLE:
EXISTING FLOOR PLANS

A1.1

DATE: 06/10/2022


PROJECT NUMBER: 21-530

REVISIONS:

-	X



1 FIRST FLOOR PLAN
AREA OF ADDITION 4,606sf

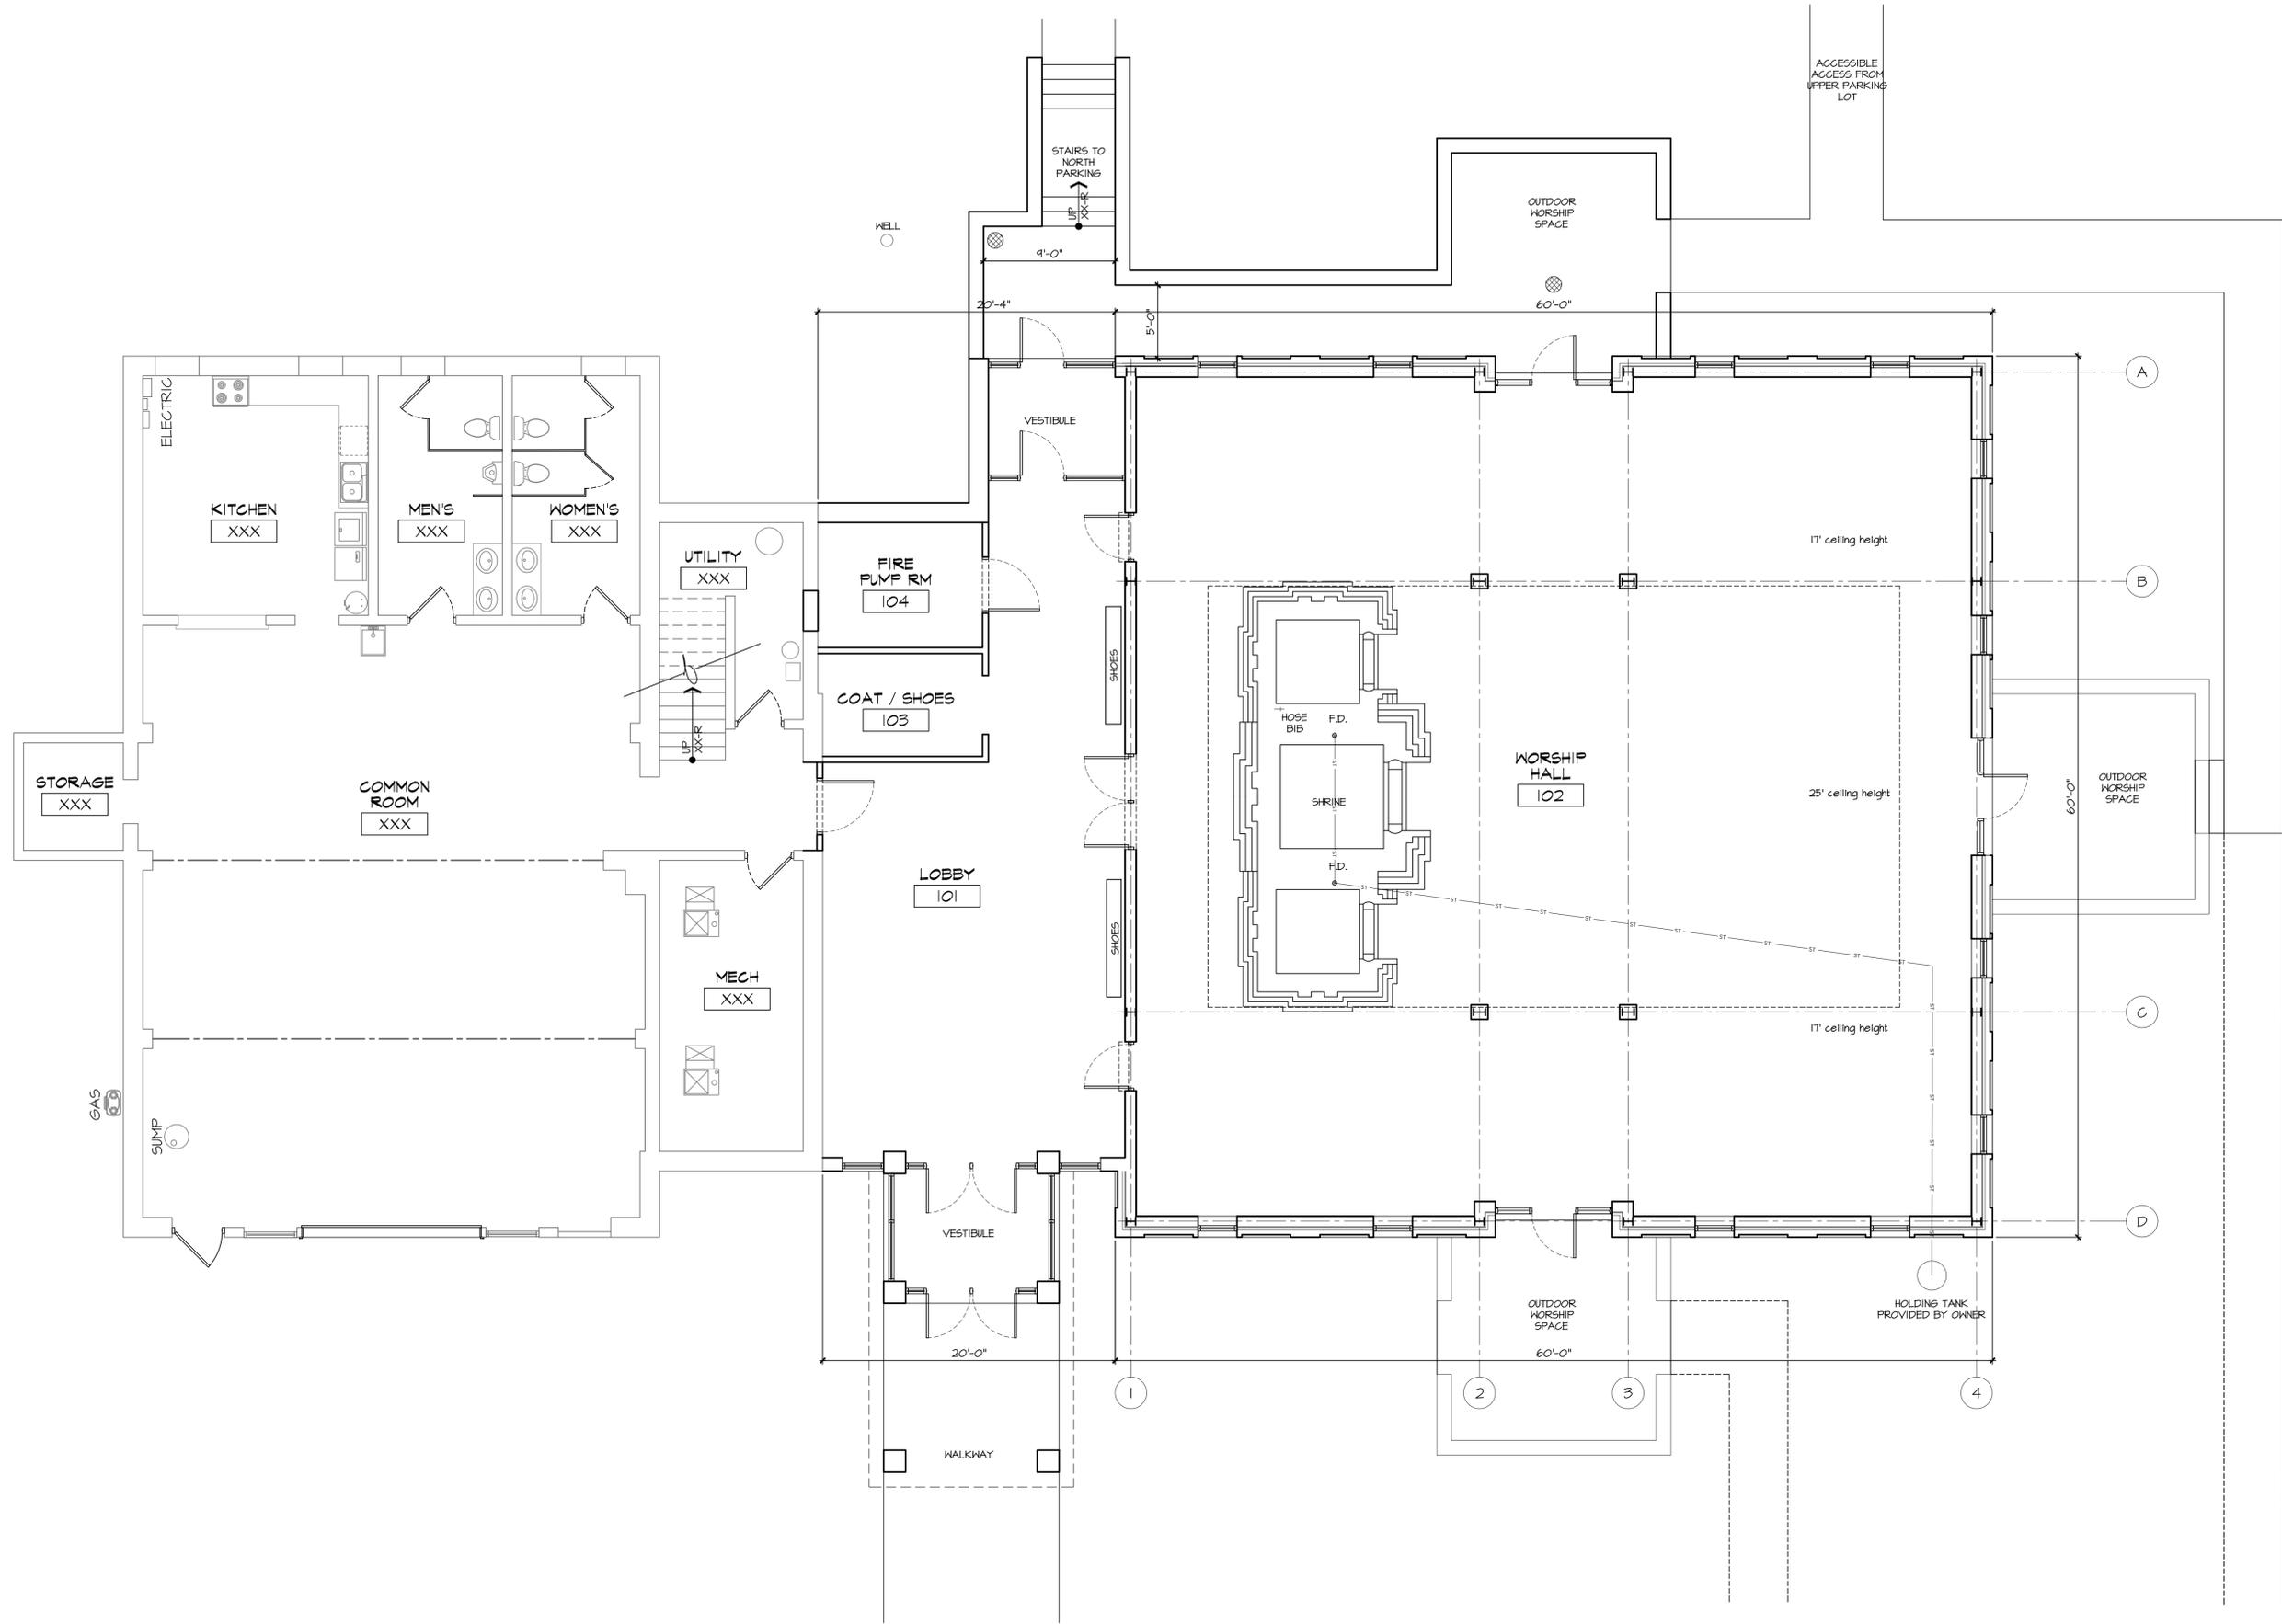

SCALE: 3/16" = 1'-0"

REVISIONS:

-	X

Sri Lakshmi Narasimha Temple


3705 S. Swartz Rd.
New Berlin, WI

SHEET TITLE:
PROPOSED GROUND FLOOR PLANS

A1.2


DATE: 06/10/2022

PROJECT NUMBER: 21-530

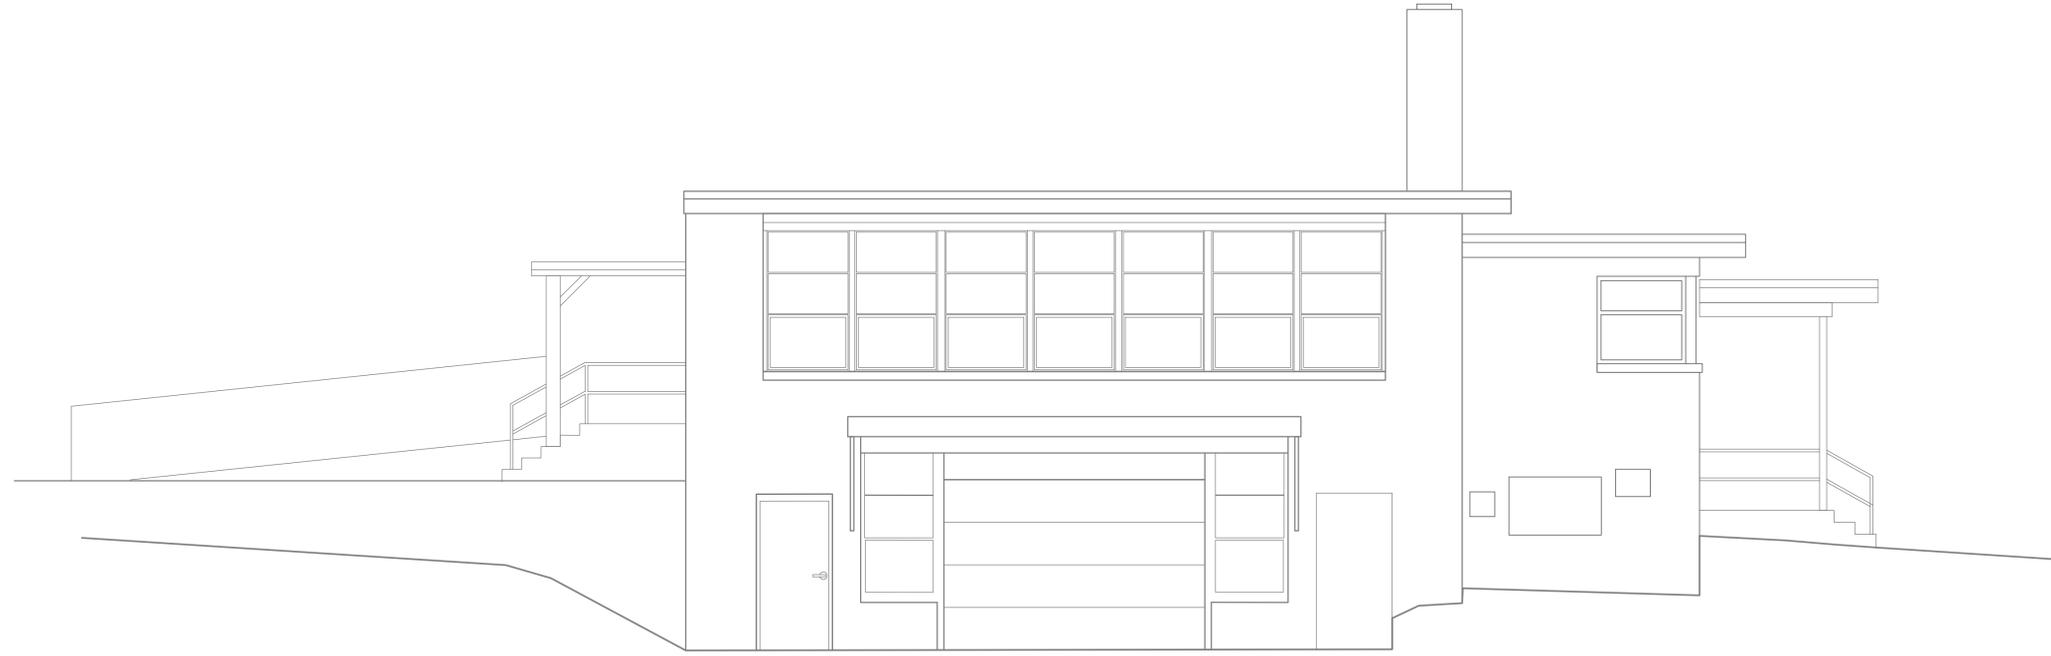

2 EXISTING SOUTH ELEVATION

SCALE: 1/4" = 1'-0"

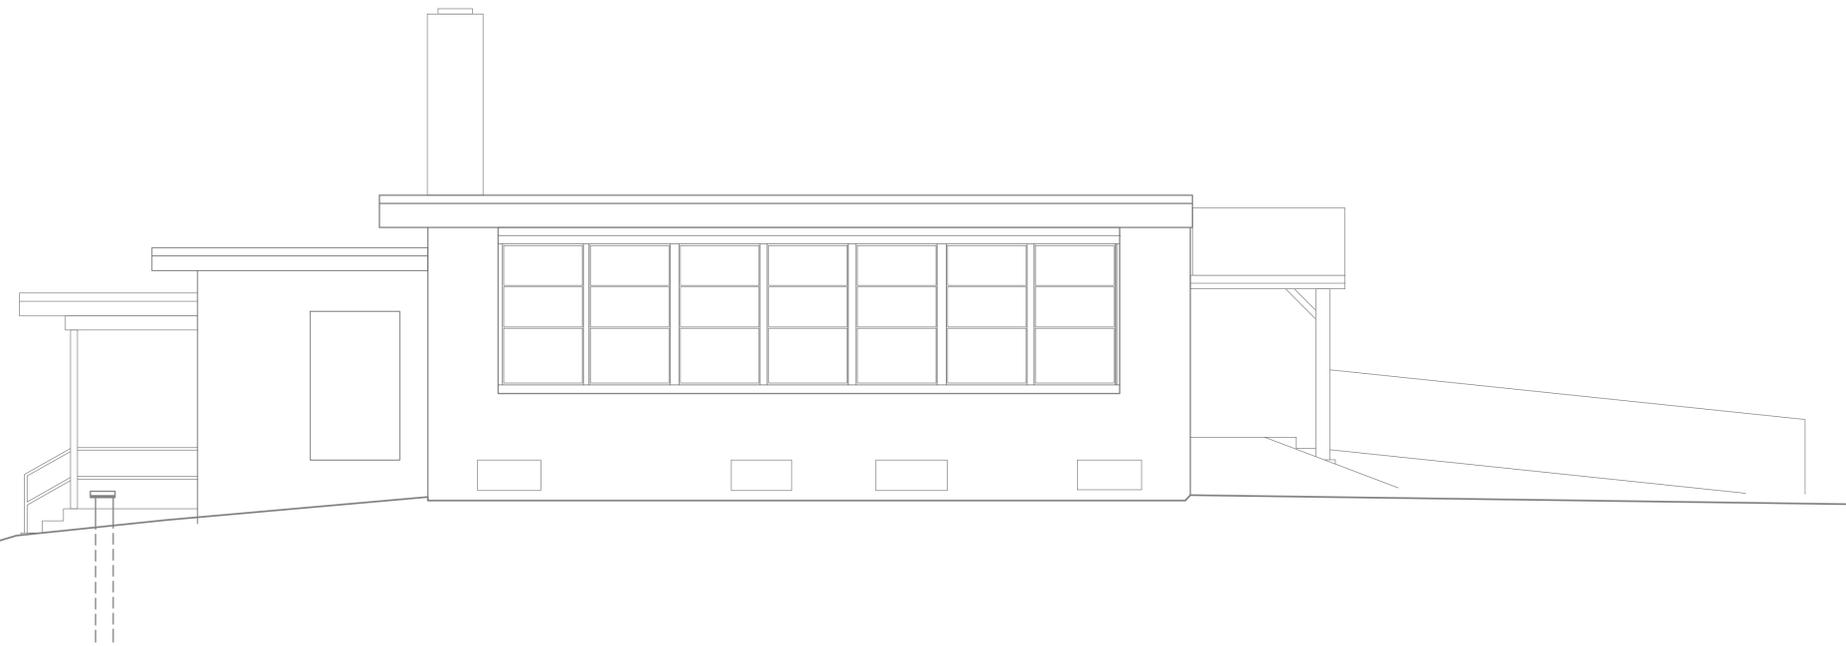

1 EXISTING NORTH ELEVATION

SCALE: 1/4" = 1'-0"

REVISIONS:

- X

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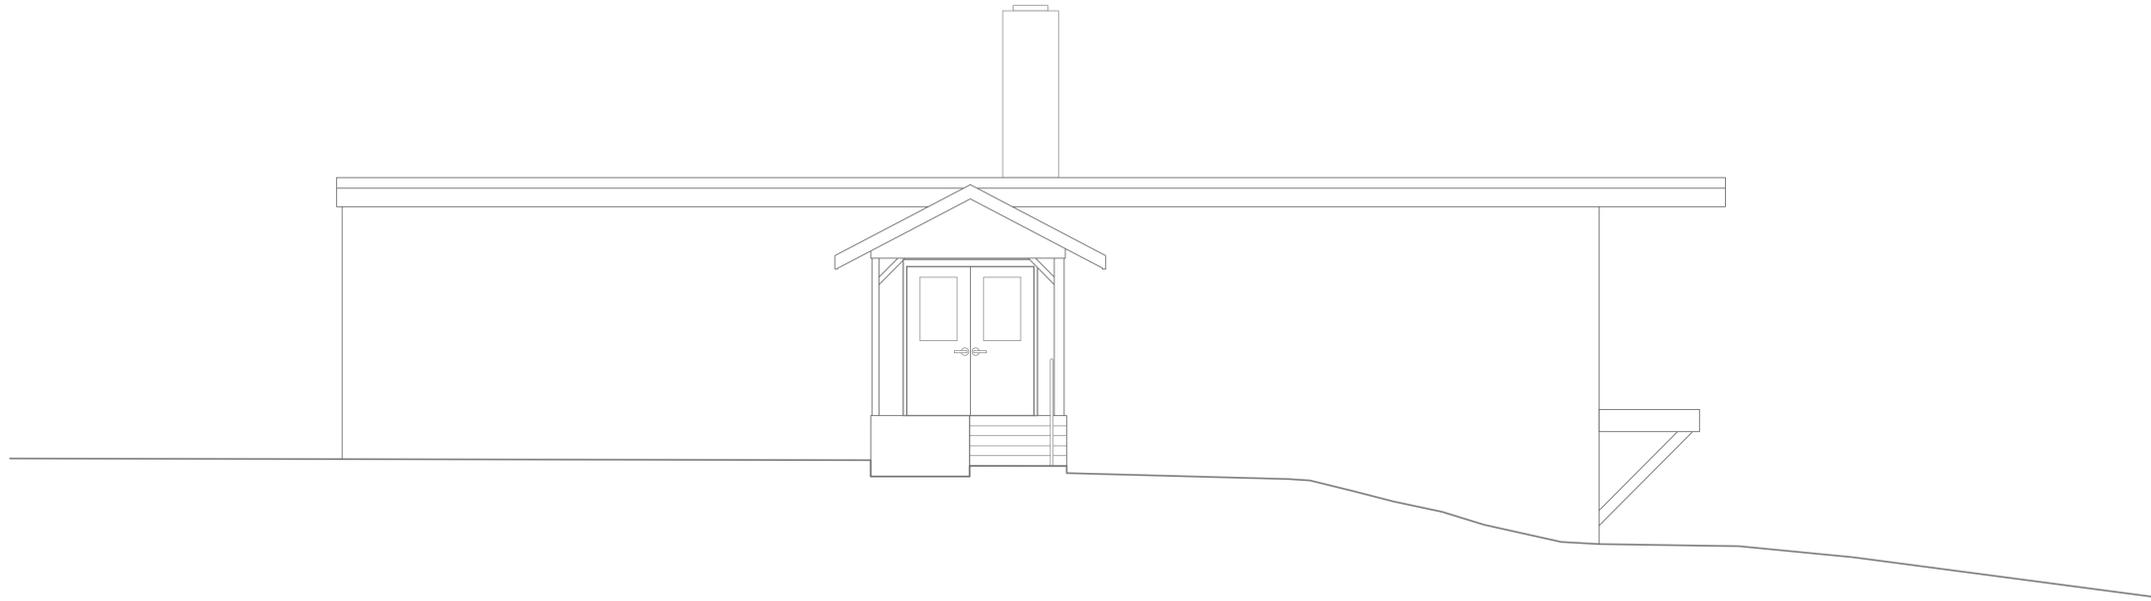
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4 EXISTING WEST ELEVATION

SCALE: 1/4" = 1'-0"



3 EXISTING EAST ELEVATION

SCALE: 1/4" = 1'-0"

REVISIONS:

-	X

Sri Lakshmi Narasimha Temple

3705 S. Swartz Rd.
New Berlin, WI

SHEET TITLE:
EXISTING ELEVATIONS

A2.2

DATE: 06/10/2022

PROJECT NUMBER: 21-530

ELEVATION CODED NOTES:

- ① DECORATIVE TRIM - SMOOTH FACED
- ② MASONRY UNIT - ROUGH FACED
- ③ MASONRY UNIT - BULL NOSE
- ④ MASONRY UNIT
- ⑤ EIFS
- ⑥ ALUMINUM WINDOW

ELEVATION LEGEND

- VISION GLASS
- T - TEMPERED GLASS
- C.J. - CONTROL JOINT
- WINDOW TYPE, REFER TO SHEET A2.1 & A2.2.

EXTERIOR ELEVATION GENERAL NOTES

1. CONTRACTOR TO FIELD VERIFY ALL ROUGH OPENINGS.
2. WINDOW SYSTEM TO BE EXTERIOR GLAZED.
3. ALL EXTERIOR MATERIALS TO BE APPROVED BY THE ARCHITECT BEFORE INSTALLATION.
4. ALL MASONRY, MASONRY VENEER, EIFS, etc. SHALL HAVE CONTROL JOINTS SPACED PER INSTITUTE MINIMUM STANDARDS. CONTACT ARCHITECT FOR LOCATIONS NOT INDICATED ON THE PLANS.



2 PROPOSED EAST ELEVATION

SCALE: 3/16" = 1'-0"

REVISIONS:

-	X

Sri Lakshmi Narasimha Temple

3705 S. Swartz Rd.
New Berlin, WI

SHEET TITLE:
PROPOSED ELEVATIONS

A2.3

DATE: 06/10/2022

PROJECT NUMBER: 21-530

1 PROPOSED SOUTH ELEVATION

SCALE: 3/16" = 1'-0"

ELEVATION CODED NOTES:


- ① DECORATIVE TRIM - SMOOTH FACED
- ② MASONRY UNIT - ROUGH FACED
- ③ MASONRY UNIT - BULL NOSE
- ④ MASONRY UNIT
- ⑤ EIFS
- ⑥ ALUMINUM WINDOW

ELEVATION LEGEND

- VISION GLASS
- T - TEMPERED GLASS
- C.J. - CONTROL JOINT
- WINDOW TYPE, REFER TO SHEET A2.1 & A2.2.

EXTERIOR ELEVATION GENERAL NOTES

- 1. CONTRACTOR TO FIELD VERIFY ALL ROUGH OPENINGS.
- 2. WINDOW SYSTEM TO BE EXTERIOR GLAZED.
- 3. ALL EXTERIOR MATERIALS TO BE APPROVED BY THE ARCHITECT BEFORE INSTALLATION.
- 4. ALL MASONRY, MASONRY VENEER, EIFS, etc. SHALL HAVE CONTROL JOINTS SPACED PER INSTITUTE MINIMUM STANDARDS. CONTACT ARCHITECT FOR LOCATIONS NOT INDICATED ON THE PLANS.

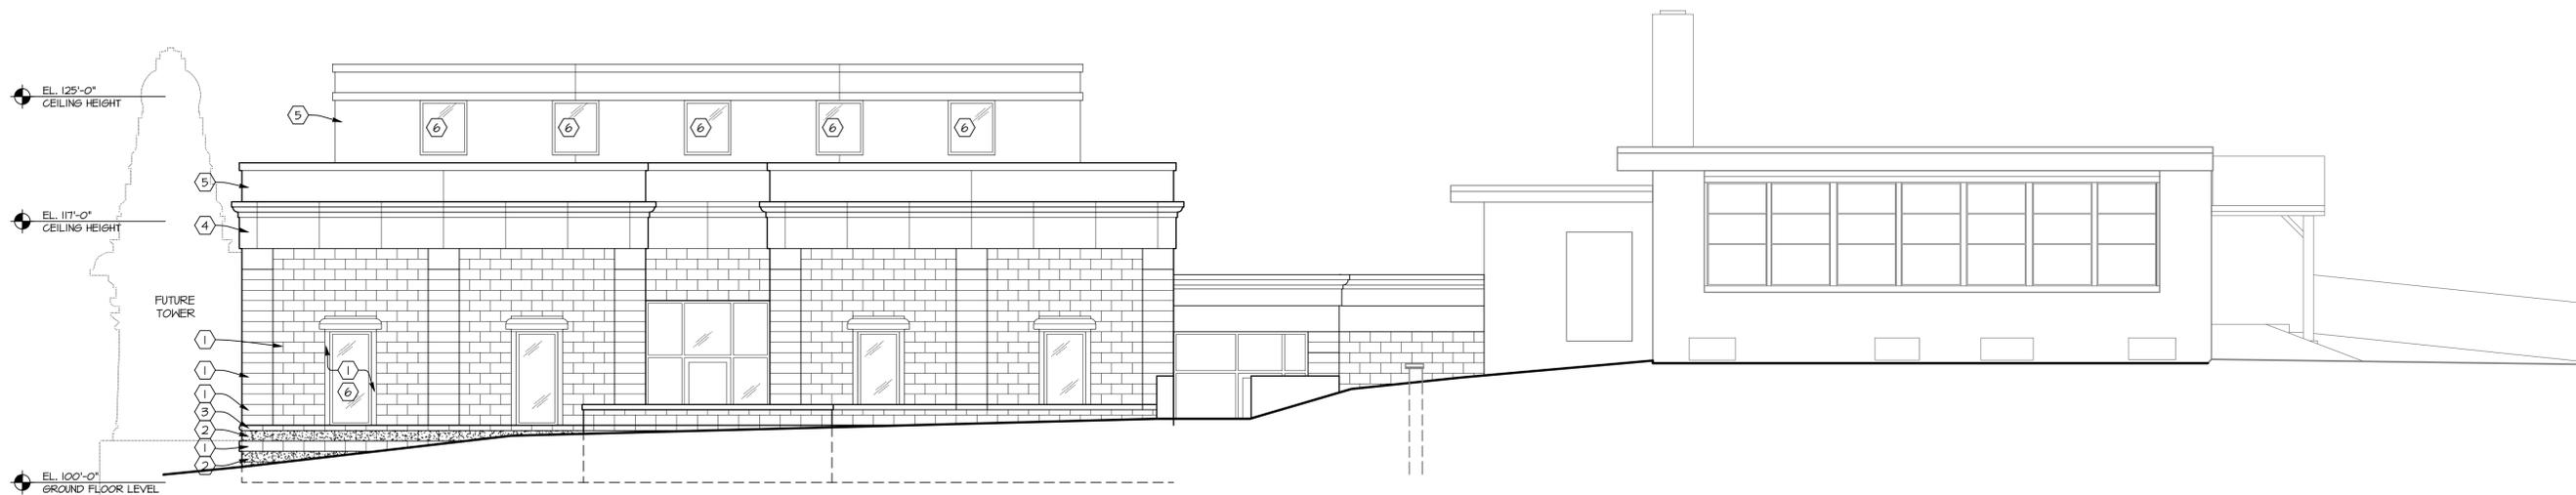

① PROPOSED NORTH ELEVATION

SCALE: 3/16" = 1'-0"

REVISIONS:

-	X

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SHEET TITLE:
PROPOSED ELEVATIONS

A2.4

DATE: 06/10/2022

PROJECT NUMBER: 21-530